

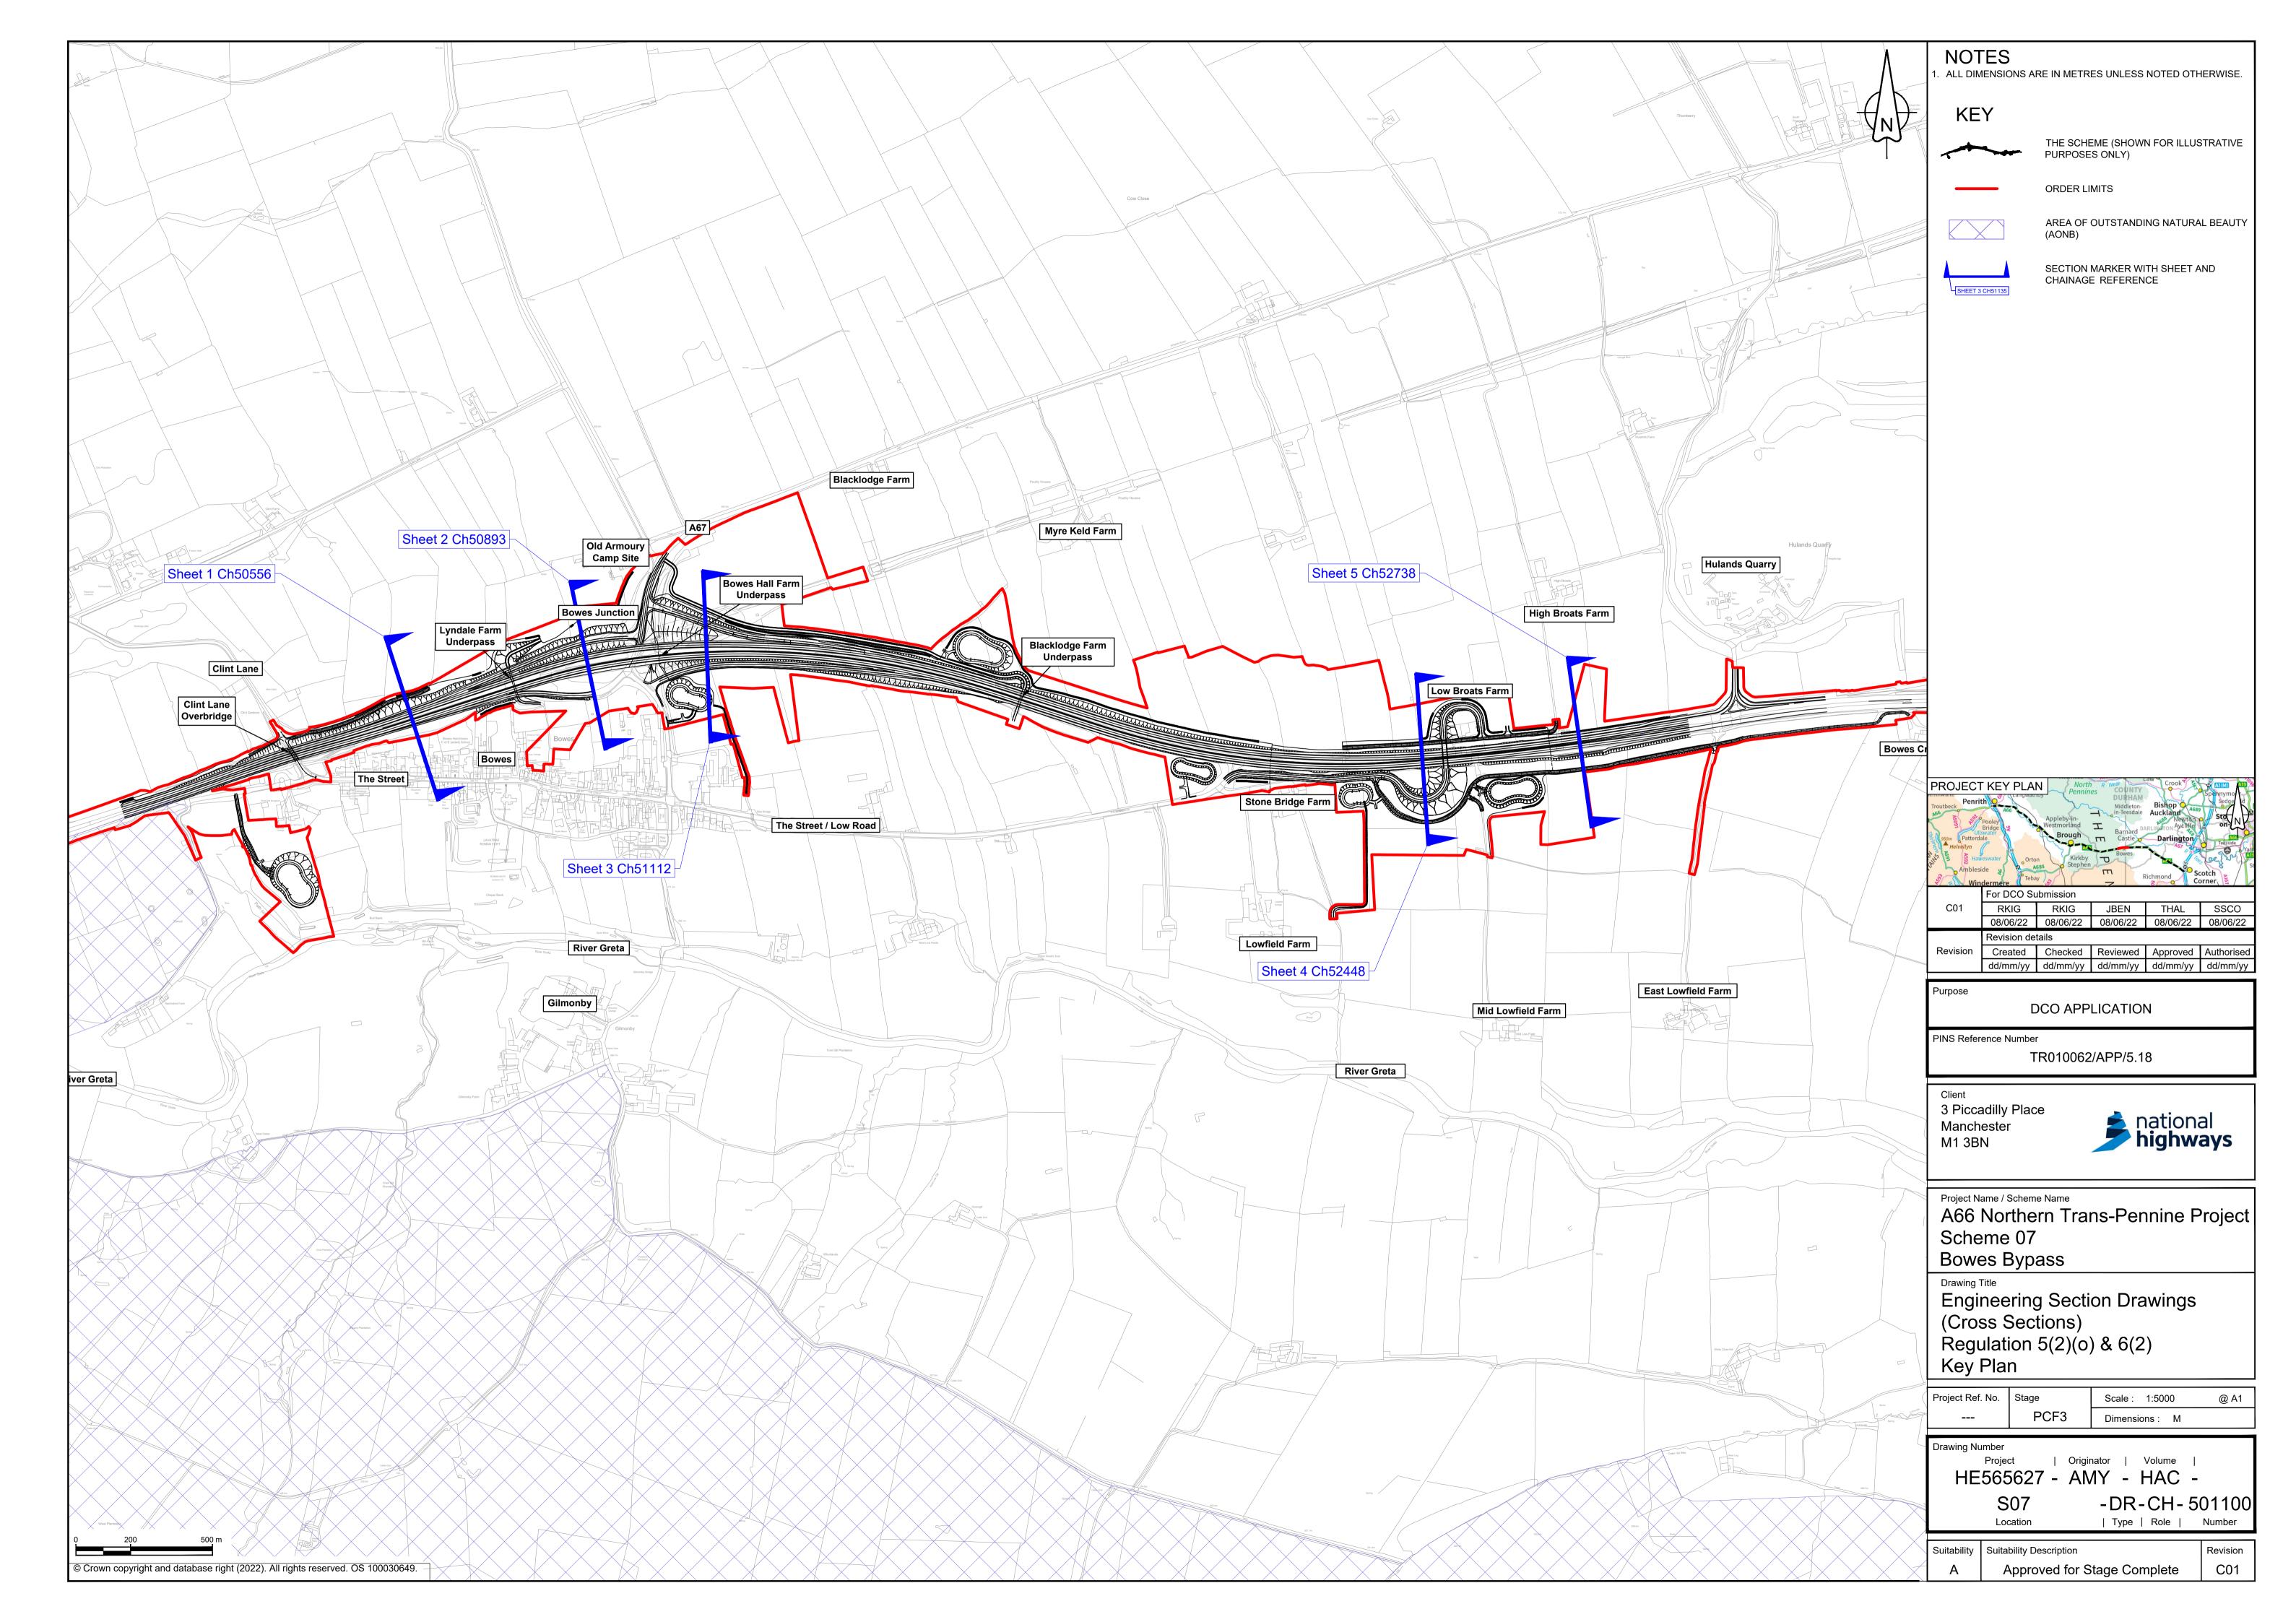
APFP Regulations 5(2)(o) and 6(2)

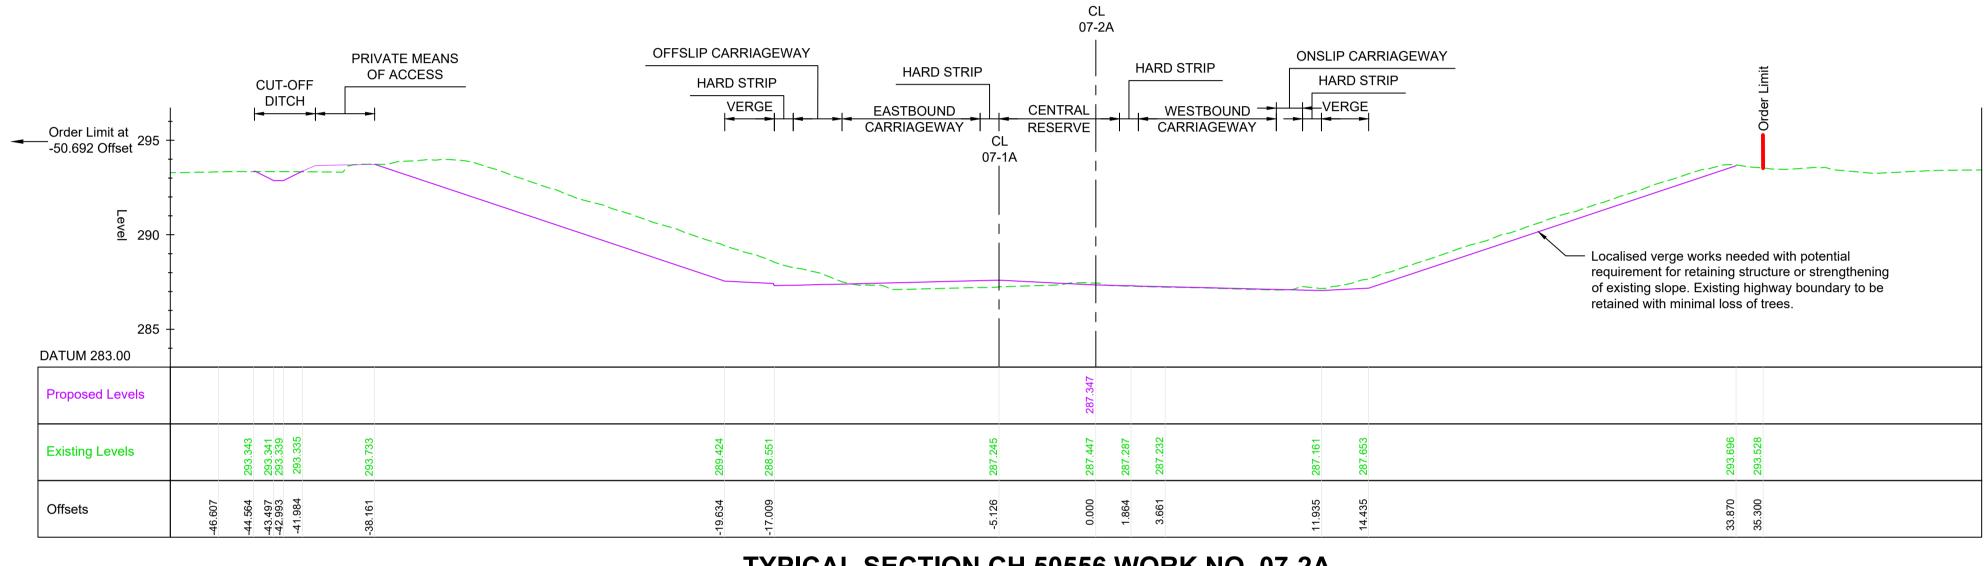
Infrastructure Planning (Applications: Prescribed Forms and **Procedure) Regulations 2009**

A66 Northern Trans-Pennine Project Scheme 07: Bowes Bypass TR010062 **5.18 Engineering Section Drawings** (Cross Sections)

Planning Act 2008

June 2022

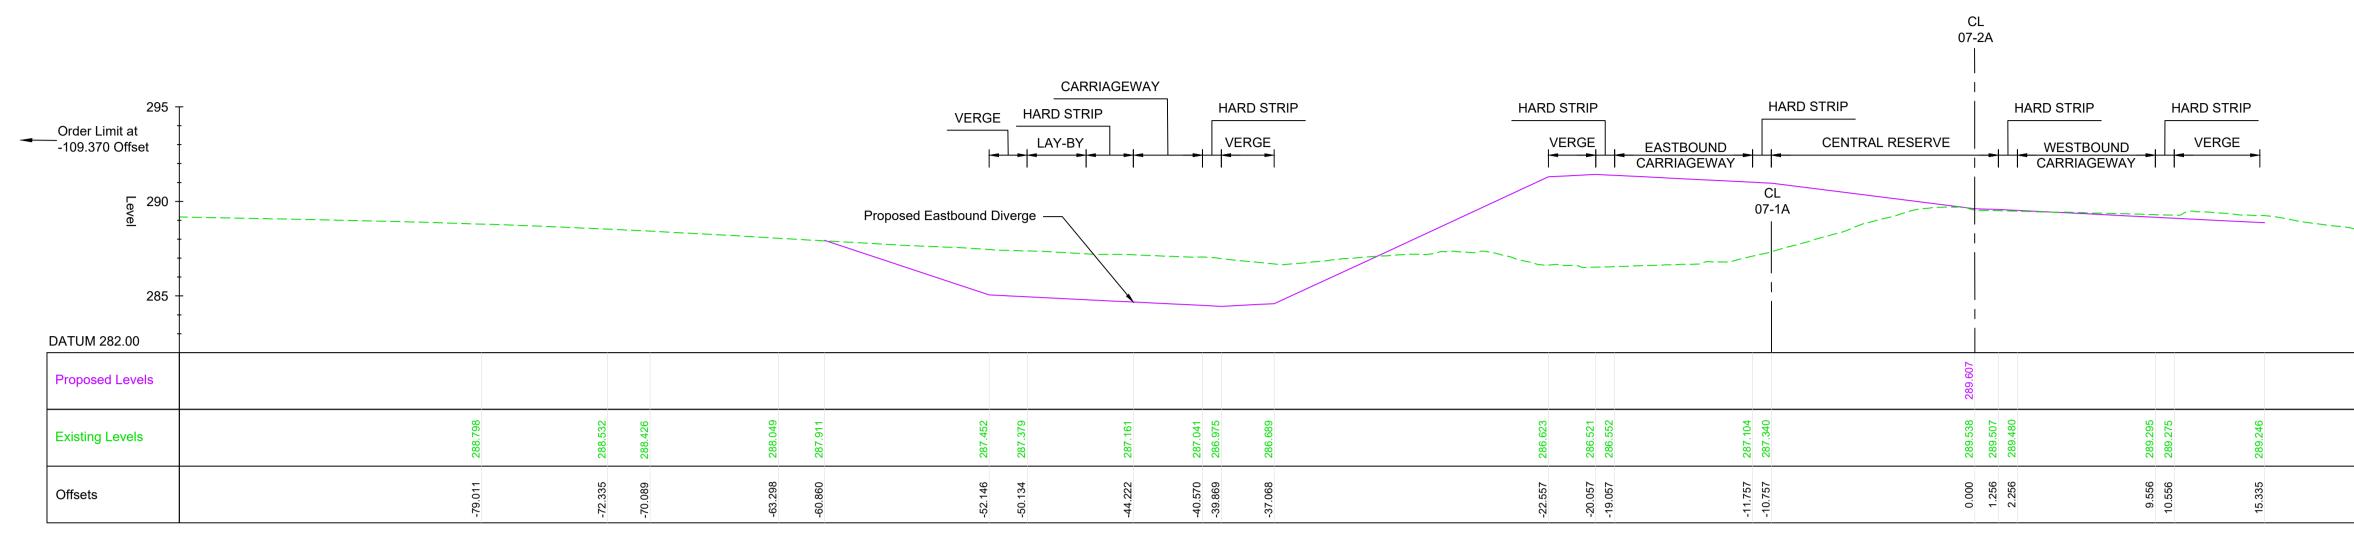


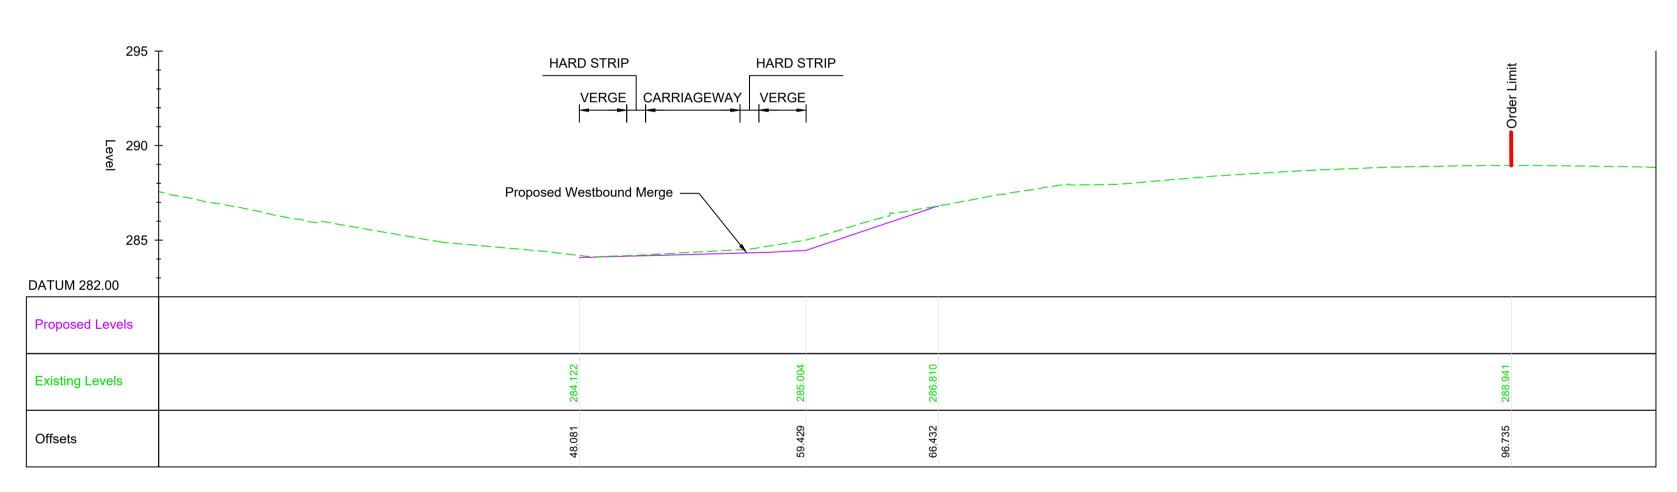


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TYPICAL SECTION CH 50556 WORK NO. 07-2A SCALE 1:200

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Purpose		dd/mm/yy			
PINS Re	DCO APPLICATION PINS Reference Number				
Man	Client 3 Piccadilly Place Manchester M1 3BN				
A60 Sch Bov	t Name / Scheme Name 6 Northern Trans-Pennine P neme 07 wes Bypass ng Title	roject			
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Project F	Ref. No. Stage Scale : 1:200 PCF3 Dimensions : M	@ A1			
_	Number Project Originator Volume E565627 - AMY - HAC - S07 - DR-CH- 50 Location Type Role	D1101 Number			
Suitabilit A	ty Suitability Description Approved for Stage Complete	Revision C01			





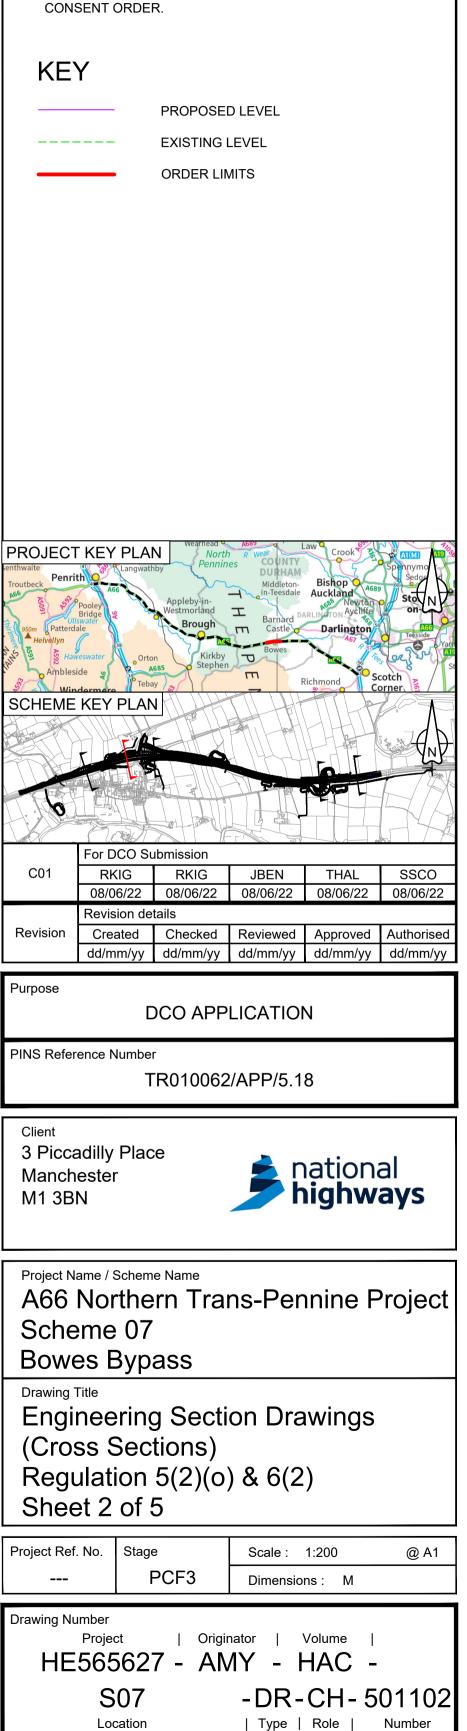


TYPICAL SECTION CH 50893 (CONT.) WORK NO. 07-2A

SCALE 1:200

NOTES

- ALL DIMENSIONS ARE IN METRES UNLESS NOTED OTHERWISE.
- 2. THESE ENGINEERING SECTION DRAWINGS SHOULD BE READ IN CONJUNCTION WITH THE KEY PLAN AND ALONGSIDE OTHER PLANS AND DOCUMENTS IN THE DEVELOPMENT CONSENT ORDER APPLICATION, IN PARTICULAR, THE
- WORKS PLANS AND SCHEDULE 1 (AUTHORISED DEVELOPMENT) TO THE DEVELOPMENT CONSENT ORDER. FOR CHAINAGE PLEASE REFER TO THE ENGINEERING
- 3 SECTION DRAWINGS (PLAN AND PROFILES).
- 4. WORK No. REFERENCES ARE DETAILED IN THE SCHEDULE 1 (AUTHORISED DEVELOPMENT) TO THE DEVELOPMENT CONSENT ORDER.
- THE DESIGN SHOWN ON THESE ENGINEERING SECTION DRAWINGS IS ILLUSTRATIVE AND WILL BE SUBJECT TO THE DETAILED DESIGN DEVELOPMENT; ANY CHANGES WILL BE LIMITED TO BEING WITHIN THE ORDER LIMITS AND ANY OTHER CONSTRAINTS INCLUDED IN THE DEVELOPMENT CONSENT ORDER.

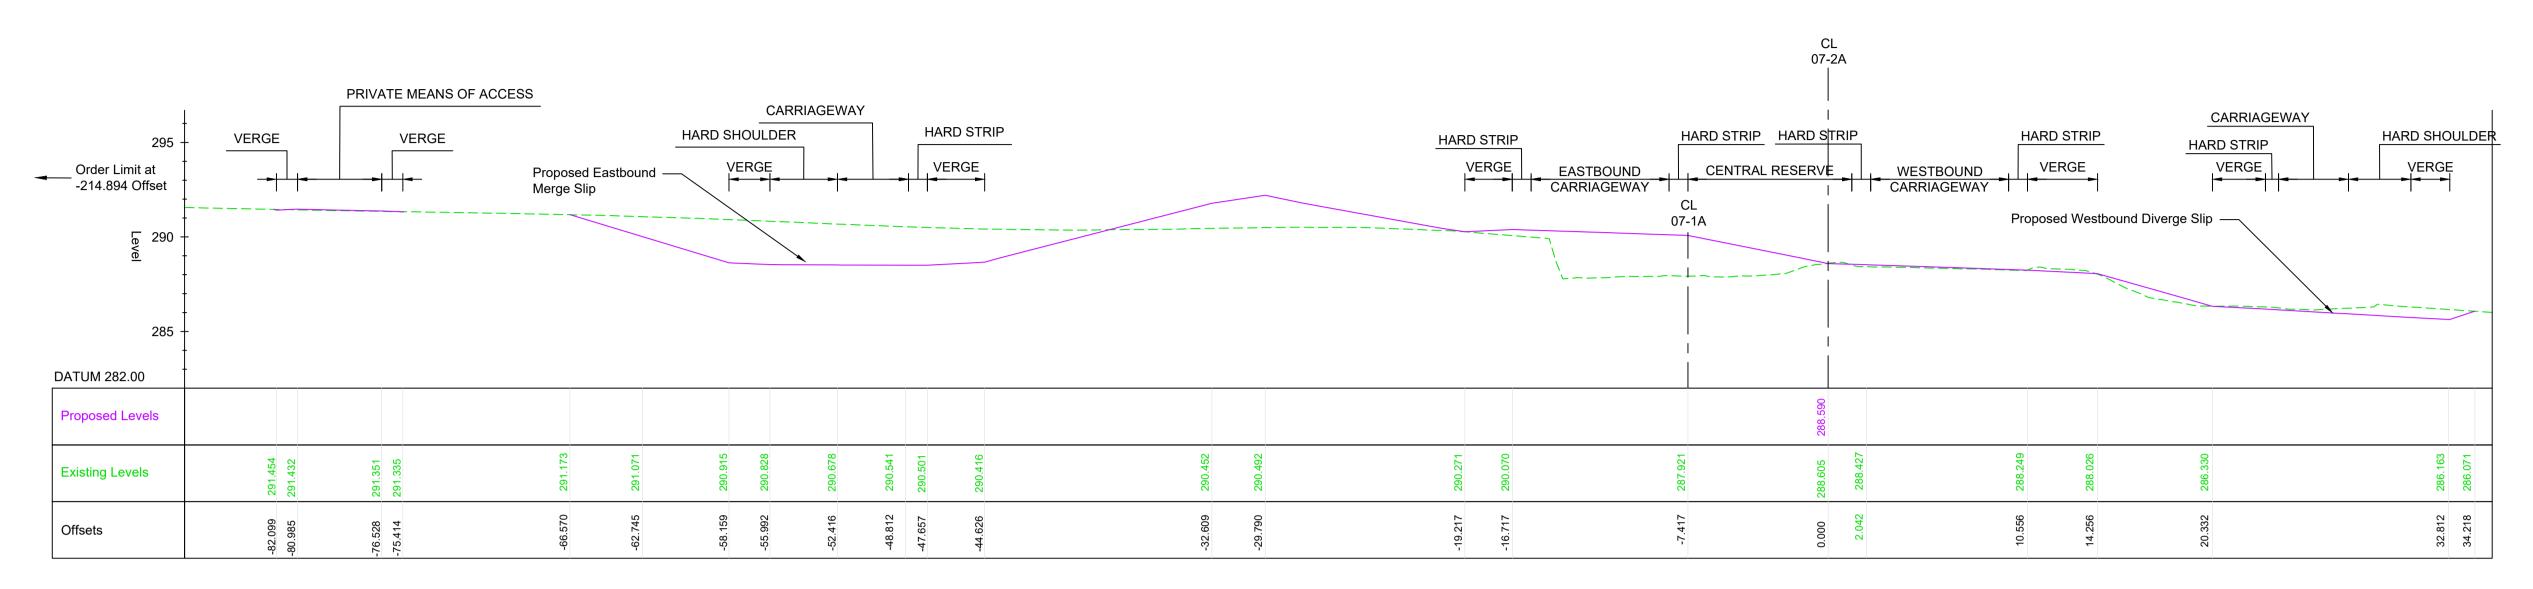


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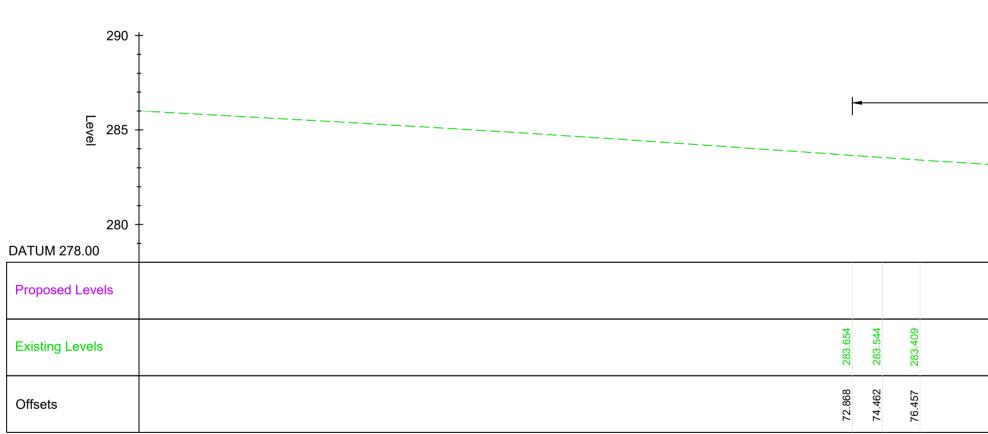
Approved for Stage Complete

Revision

C01







TYPICAL SECTION CH 51112 (CONT.) WORK NO. 07-2A

TYPICAL SECTION CH 51112 WORK NO. 07-2A SCALE 1:200

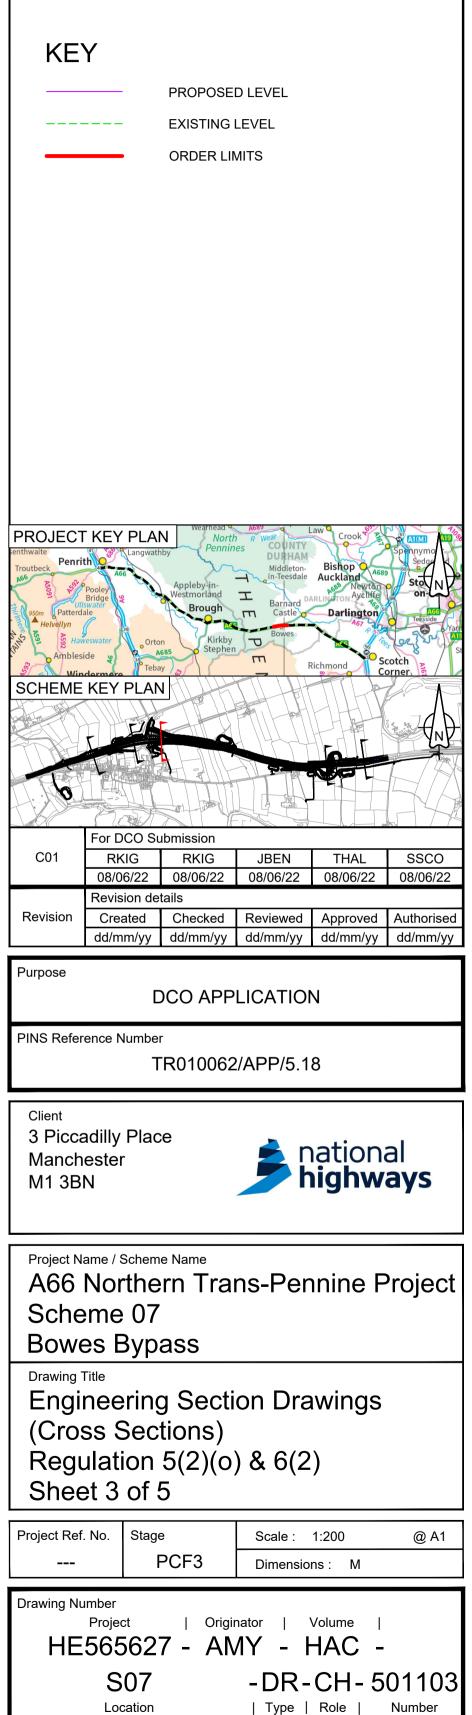
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SCALE 1:200

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- ALL DIMENSIONS ARE IN METRES UNLESS NOTED OTHERWISE.
- 2. THESE ENGINEERING SECTION DRAWINGS SHOULD BE READ IN CONJUNCTION WITH THE KEY PLAN AND ALONGSIDE OTHER PLANS AND DOCUMENTS IN THE DEVELOPMENT CONSENT ORDER APPLICATION, IN PARTICULAR, THE WORKS PLANS AND SCHEDULE 1 (AUTHORISED
- DEVELOPMENT) TO THE DEVELOPMENT CONSENT ORDER. FOR CHAINAGE PLEASE REFER TO THE ENGINEERING
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- (AUTHORISED DEVELOPMENT) TO THE DEVELOPMENT CONSENT ORDER.
- 5. THE DESIGN SHOWN ON THESE ENGINEERING SECTION DRAWINGS IS ILLUSTRATIVE AND WILL BE SUBJECT TO THE DETAILED DESIGN DEVELOPMENT; ANY CHANGES WILL BE LIMITED TO BEING WITHIN THE ORDER LIMITS AND ANY OTHER CONSTRAINTS INCLUDED IN THE DEVELOPMENT CONSENT ORDER.

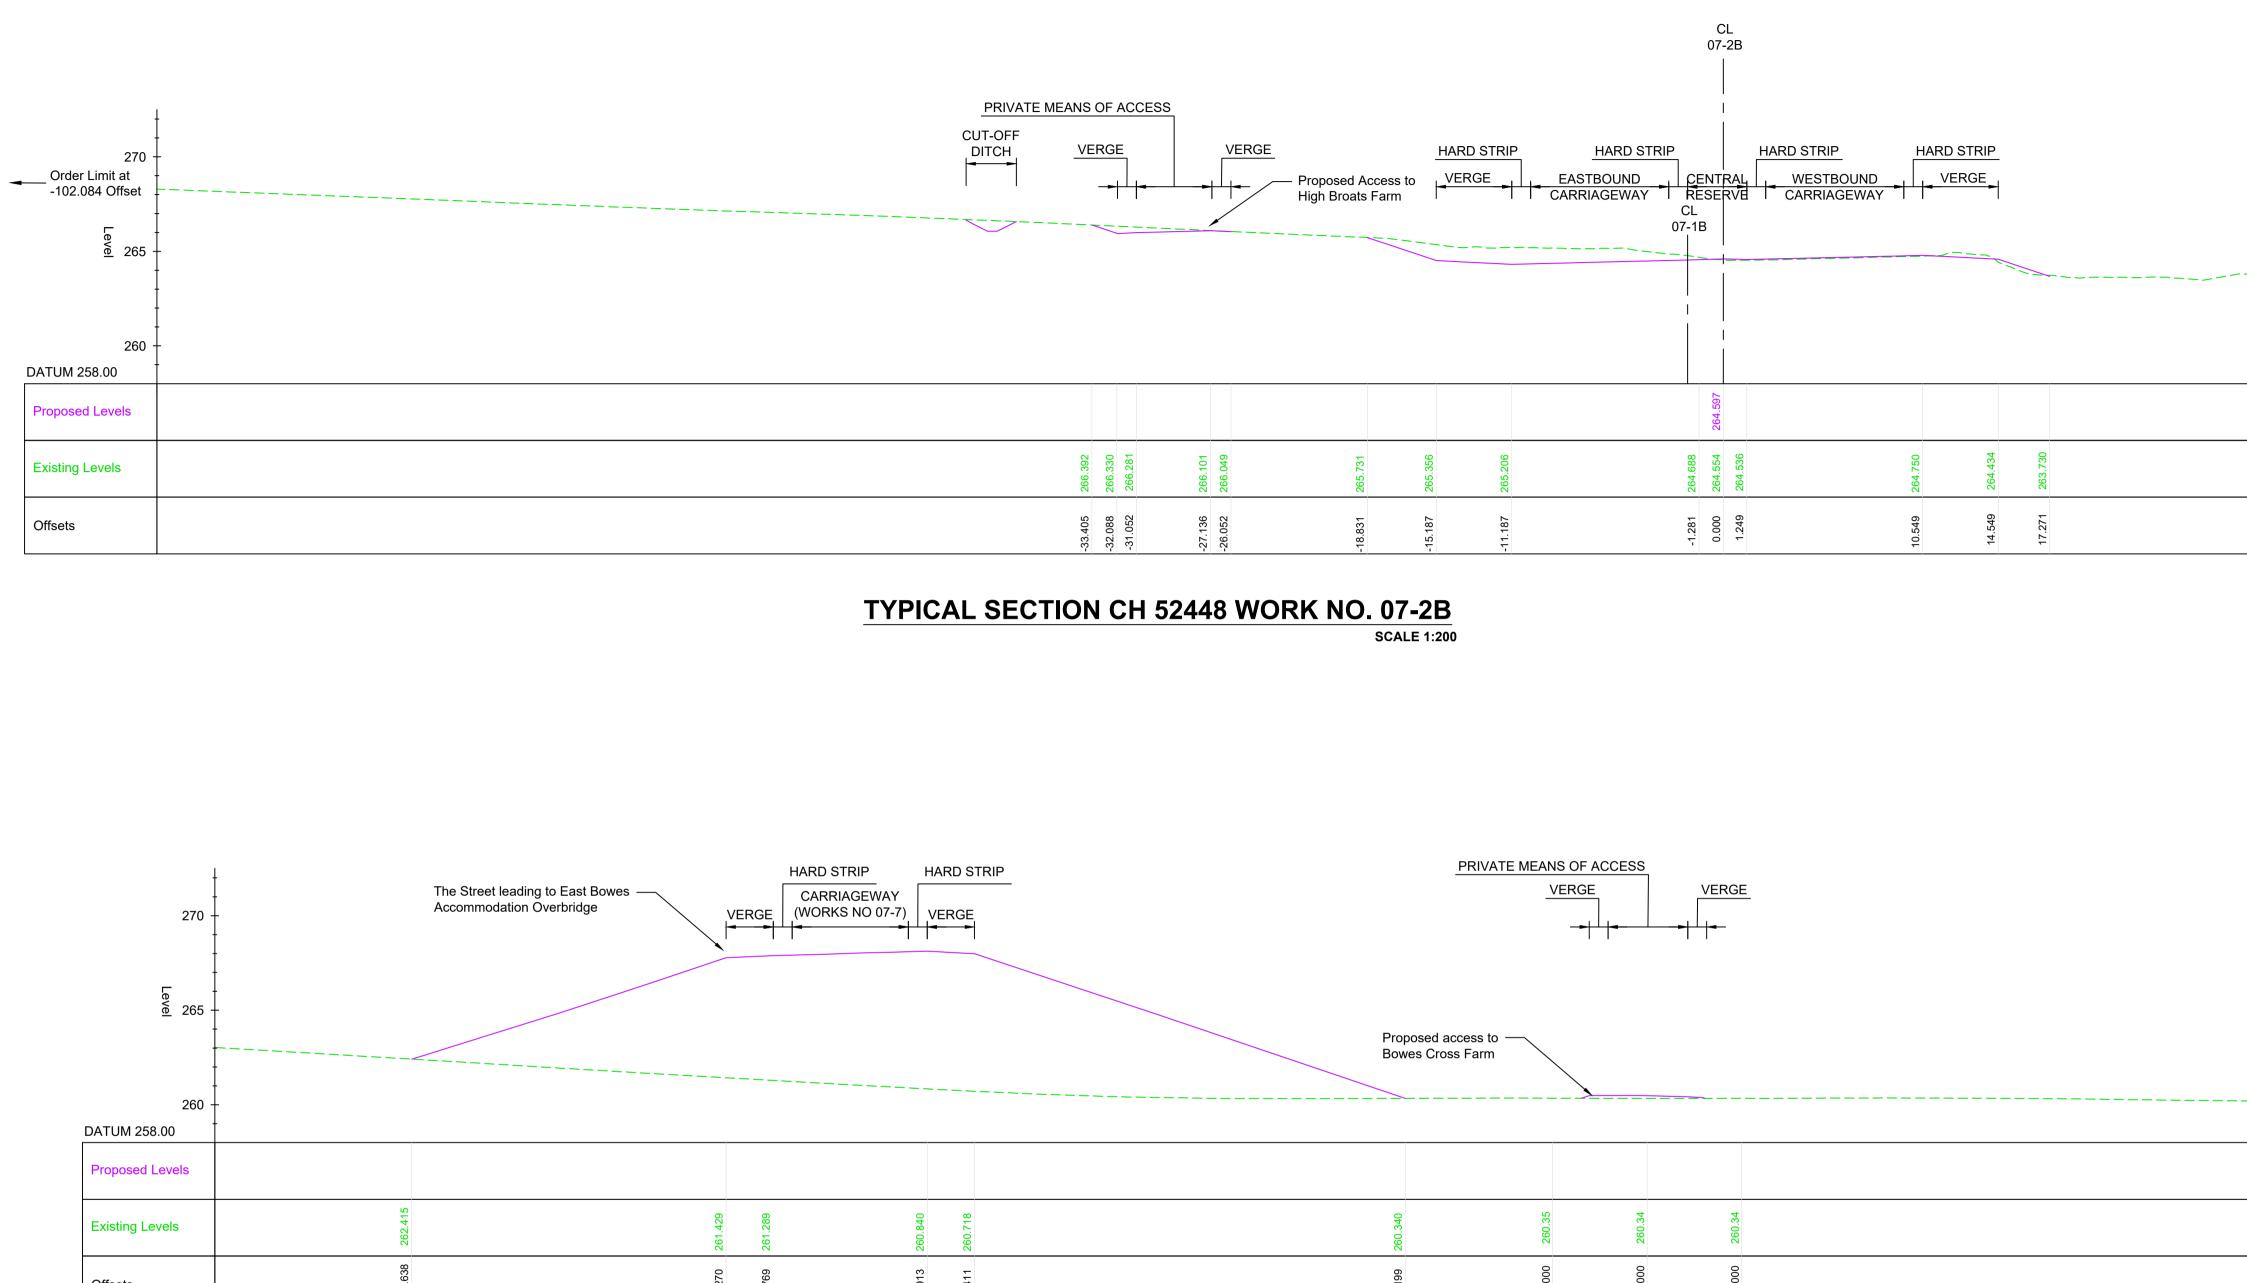


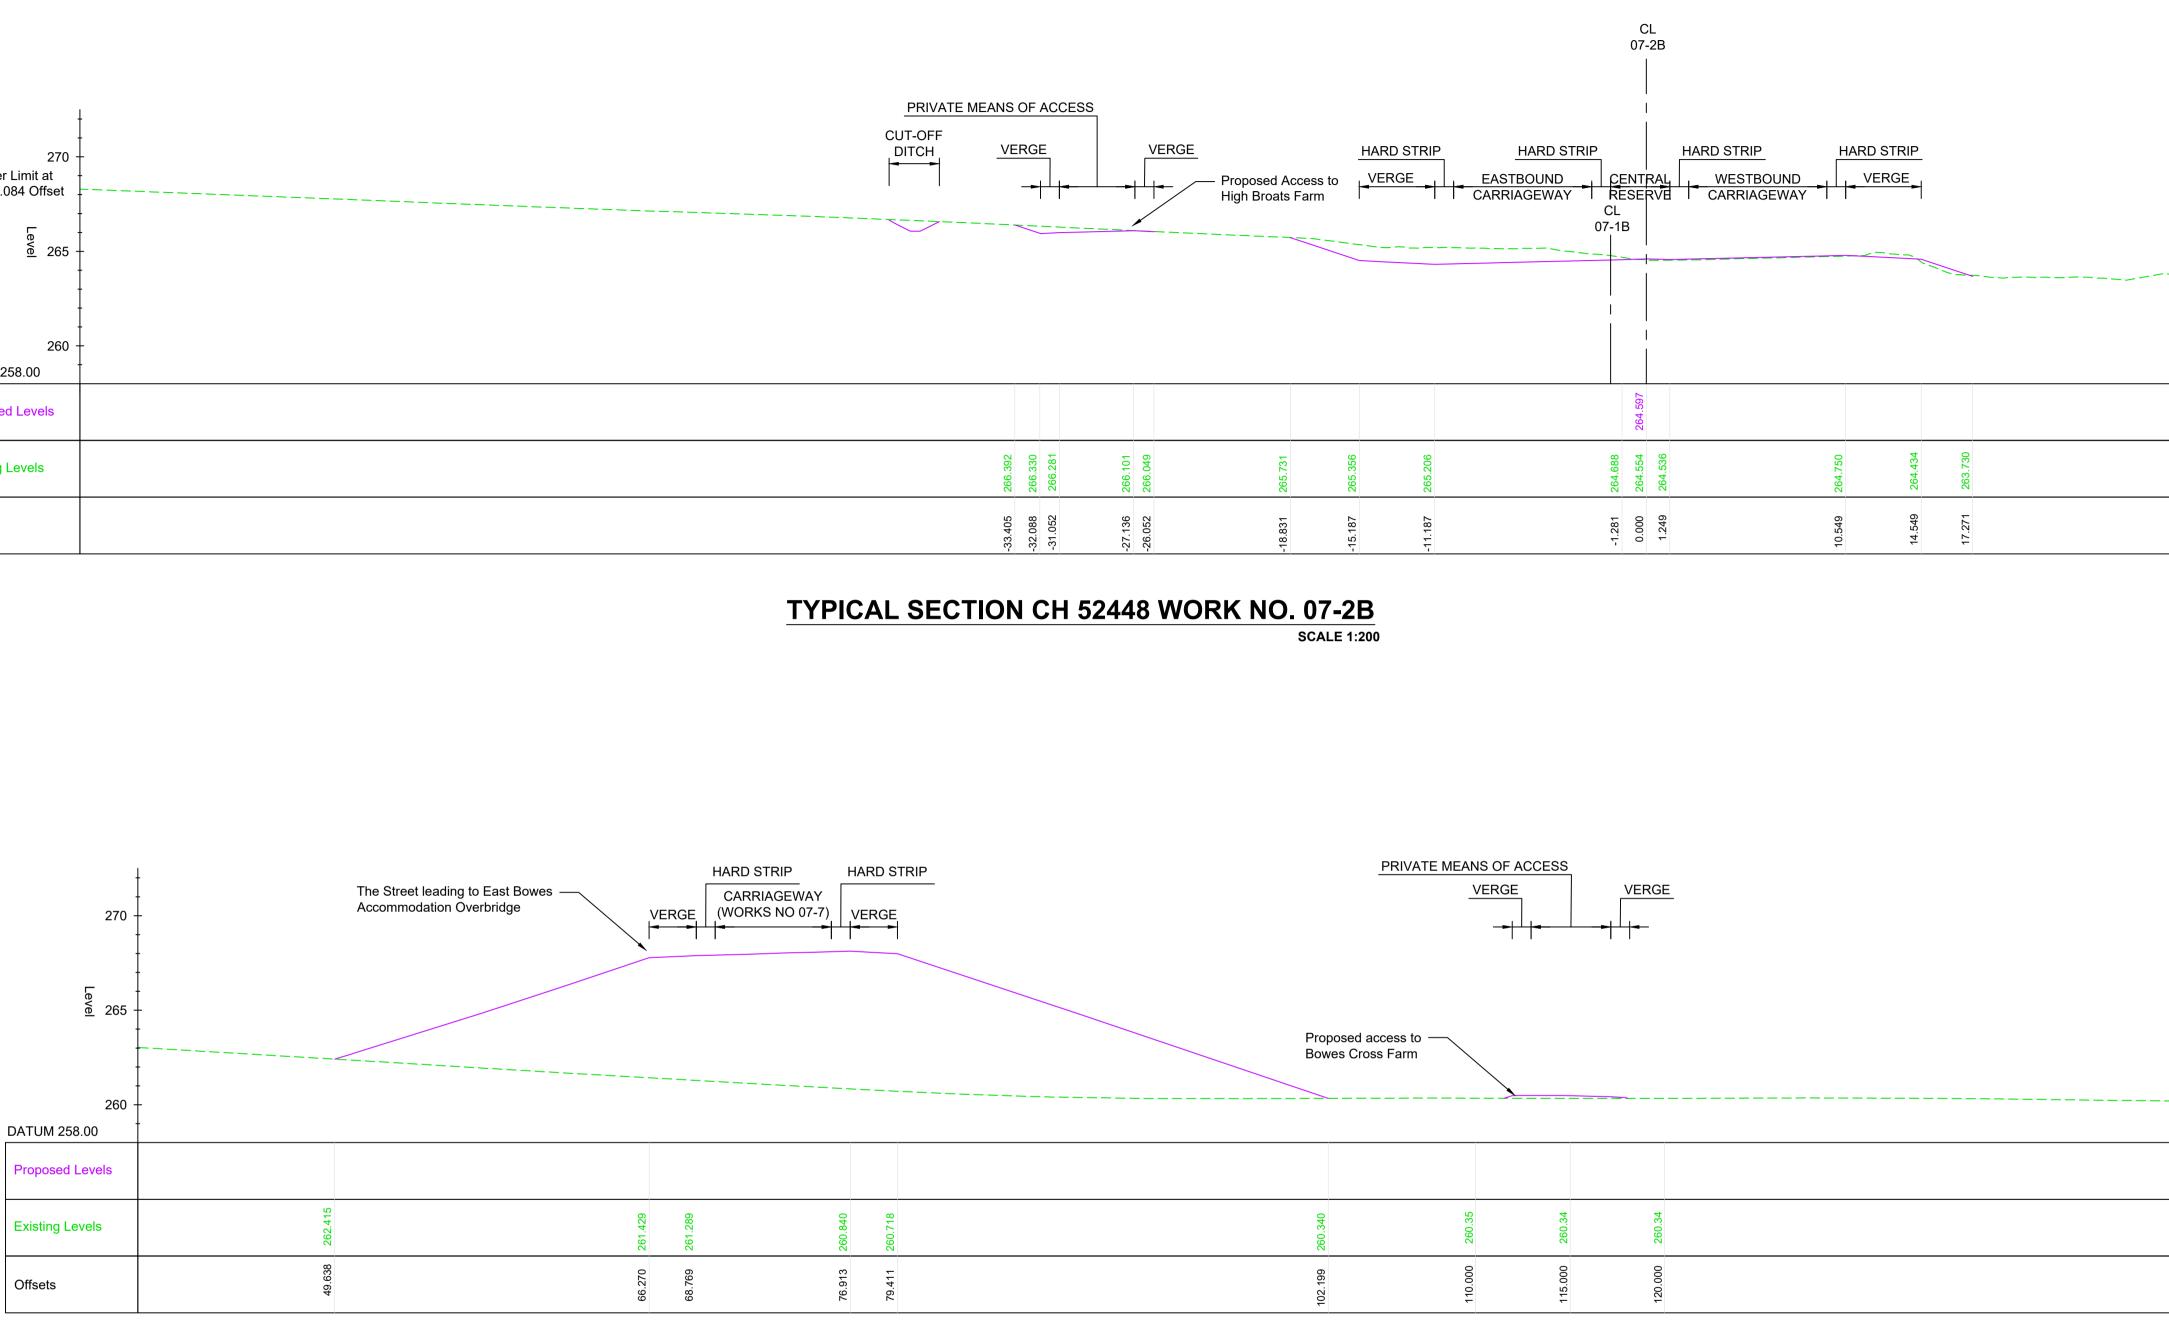
Suitability Suitability Description

Approved for Stage Complete

Revision

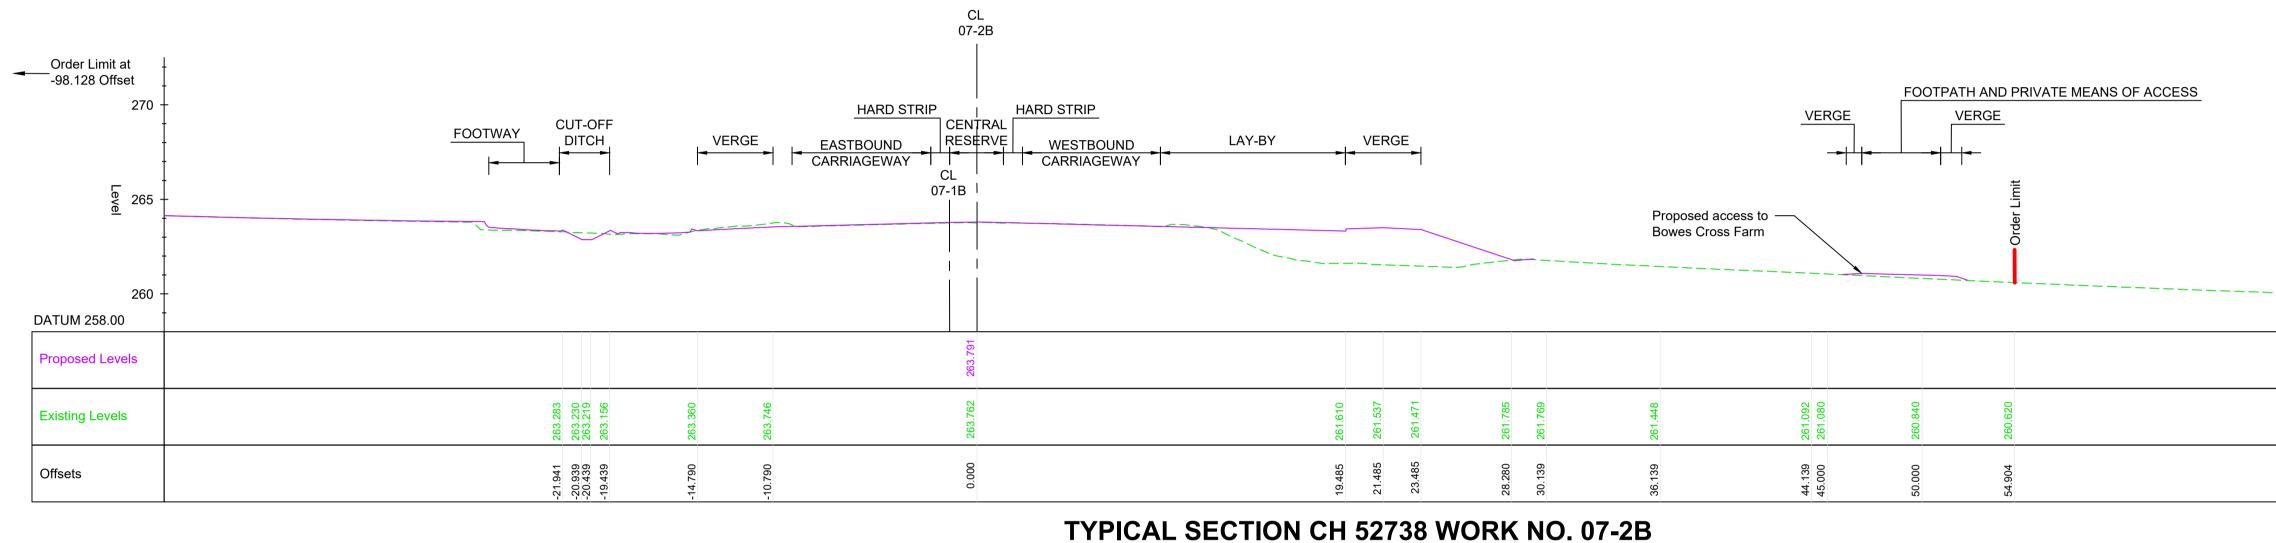
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TYPICAL SECTION CH 52448 (CONT.) WORK NO. 07-2B SCALE 1:200

	 NOTES ALL DIMENSIONS ARE IN METRES UNLESS NOTED OTHERWISE. THESE ENGINEERING SECTION DRAWINGS SHOULD BE READ IN CONJUNCTION WITH THE KEY PLAN AND ALONGSIDE OTHER PLANS AND DOCUMENTS IN THE DEVELOPMENT CONSENT ORDER APPLICATION, IN PARTICULAR, THE WORKS PLANS AND SCHEDULE 1 (AUTHORISED DEVELOPMENT) TO THE DEVELOPMENT CONSENT ORDER. FOR CHAINAGE PLEASE REFER TO THE ENGINEERING SECTION DRAWINGS (PLAN AND PROFILES). WORK NO. REFERENCES ARE DETAILED IN THE SCHEDULE 1 (AUTHORISED DEVELOPMENT) TO THE DEVELOPMENT CONSENT ORDER. THE DESIGN SHOWN ON THESE ENGINEERING SECTION DRAWINGS IS ILLUSTRATIVE AND WILL BE SUBJECT TO THE DETAILED DESIGN DEVELOPMENT; ANY CHANGES WILL BE LIMITED TO BEING WITHIN THE ORDER LIMITS AND ANY OTHER CONSTRAINTS INCLUDED IN THE DEVELOPMENT CONSENT ORDER. 		
Order Limit at 175.354 Offset	PROJECT KEY PLAN Virtual		
	Client 3 Piccadilly Place Manchester M1 3BN Project Name / Scheme Name A66 Northern Trans-Pennine Project Scheme 07 Bowes Bypass Drawing Title Engineering Section Drawings (Cross Sections) Regulation 5(2)(0) & 6(2) Sheet 4 of 5 Project Ref. No. The stage Scale: 1:200 (2) A Dimensions: M Crowing Number Project Originator Volume HE565627 - AMY - HAC -		
	AWY - HAC - S07 -DR-CH-501104 Location Type Role Number Suitability Suitability Description A Approved for Stage Complete C01		



AL SECTION CH 52736 WORK NO. 07-26 SCALE 1:200

 NOTES ALL DIMENSIONS ARE IN METRES UNLESS NOTED OTHERWISE. THESE ENGINEERING SECTION DRAWINGS SHOULD BE READ IN CONJUNCTION WITH THE KEY PLAN AND ALONGSIDE OTHER PLANS AND DOCUMENTS IN THE DEVELOPMENT CONSENT ORDER APPLICATION, IN PARTICULAR, THE WORKS PLANS AND SCHEDULE 1 (AUTHORISED DEVELOPMENT) TO THE DEVELOPMENT CONSENT ORDER. FOR CHAINAGE PLEASE REFER TO THE ENGINEERING SECTION DRAWINGS (PLAN AND PROFILES). WORK No. REFERENCES ARE DETAILED IN THE SCHEDULE 1 (AUTHORISED DEVELOPMENT) TO THE DEVELOPMENT CONSENT ORDER. THE DESIGN SHOWN ON THESE ENGINEERING SECTION DRAWINGS IS ILLUSTRATIVE AND WILL BE SUBJECT TO THE DETAILED DESIGN DEVELOPMENT; ANY CHANGES WILL BE LIMITED TO BEING WITHIN THE ORDER LIMITS AND ANY OTHER CONSTRAINTS INCLUDED IN THE DEVELOPMENT CONSENT ORDER. KEY
EXISTING LEVEL ORDER LIMITS
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For DCO Submission C01 RKIG JBEN THAL SSCO 201000000 201000000 201000000 201000000
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Purpose DCO APPLICATION
PINS Reference Number TR010062/APP/5.18
Client 3 Piccadilly Place Manchester M1 3BN
Project Name / Scheme Name A66 Northern Trans-Pennine Project Scheme 07 Bowes Bypass
Drawing Title Engineering Section Drawings (Cross Sections) Regulation 5(2)(0) & 6(2) Sheet 5 of 5
Project Ref. No. Stage Scale : 1:200 @ A1 PCF3 Dimensions : M
Drawing Number Project Originator Volume HE565627 - AMY - HAC - S07 - DR-CH- 501105
LocationTypeRoleNumberSuitabilitySuitability DescriptionRevisionAApproved for Stage CompleteC01